

SEAL

STATE OF NEW HAMPSHIRE
DAVIS DICKERSON
NO. 9022
LICENSED PROFESSIONAL ENGINEER

SIGNATURE: [Signature]
DATE: 09/13/2022 05/31/2023
EXPIRATION DATE

NO.	DATE	DESCRIPTION
1	09/13/22	SITE LIGHTING REVISION

PROJECT INFORMATION


SITE PLAN - PHOTOMETRIC

WASHVILLE TIO TUNNEL
1312 OAKLAWN AVENUE | CRANSTON RI, 02920

SHEET MANAGEMENT	PROJECT NO.: WAS94-029	DATE ISSUED: 01/17/22	SR
			DD

SHEET NUMBER

E102

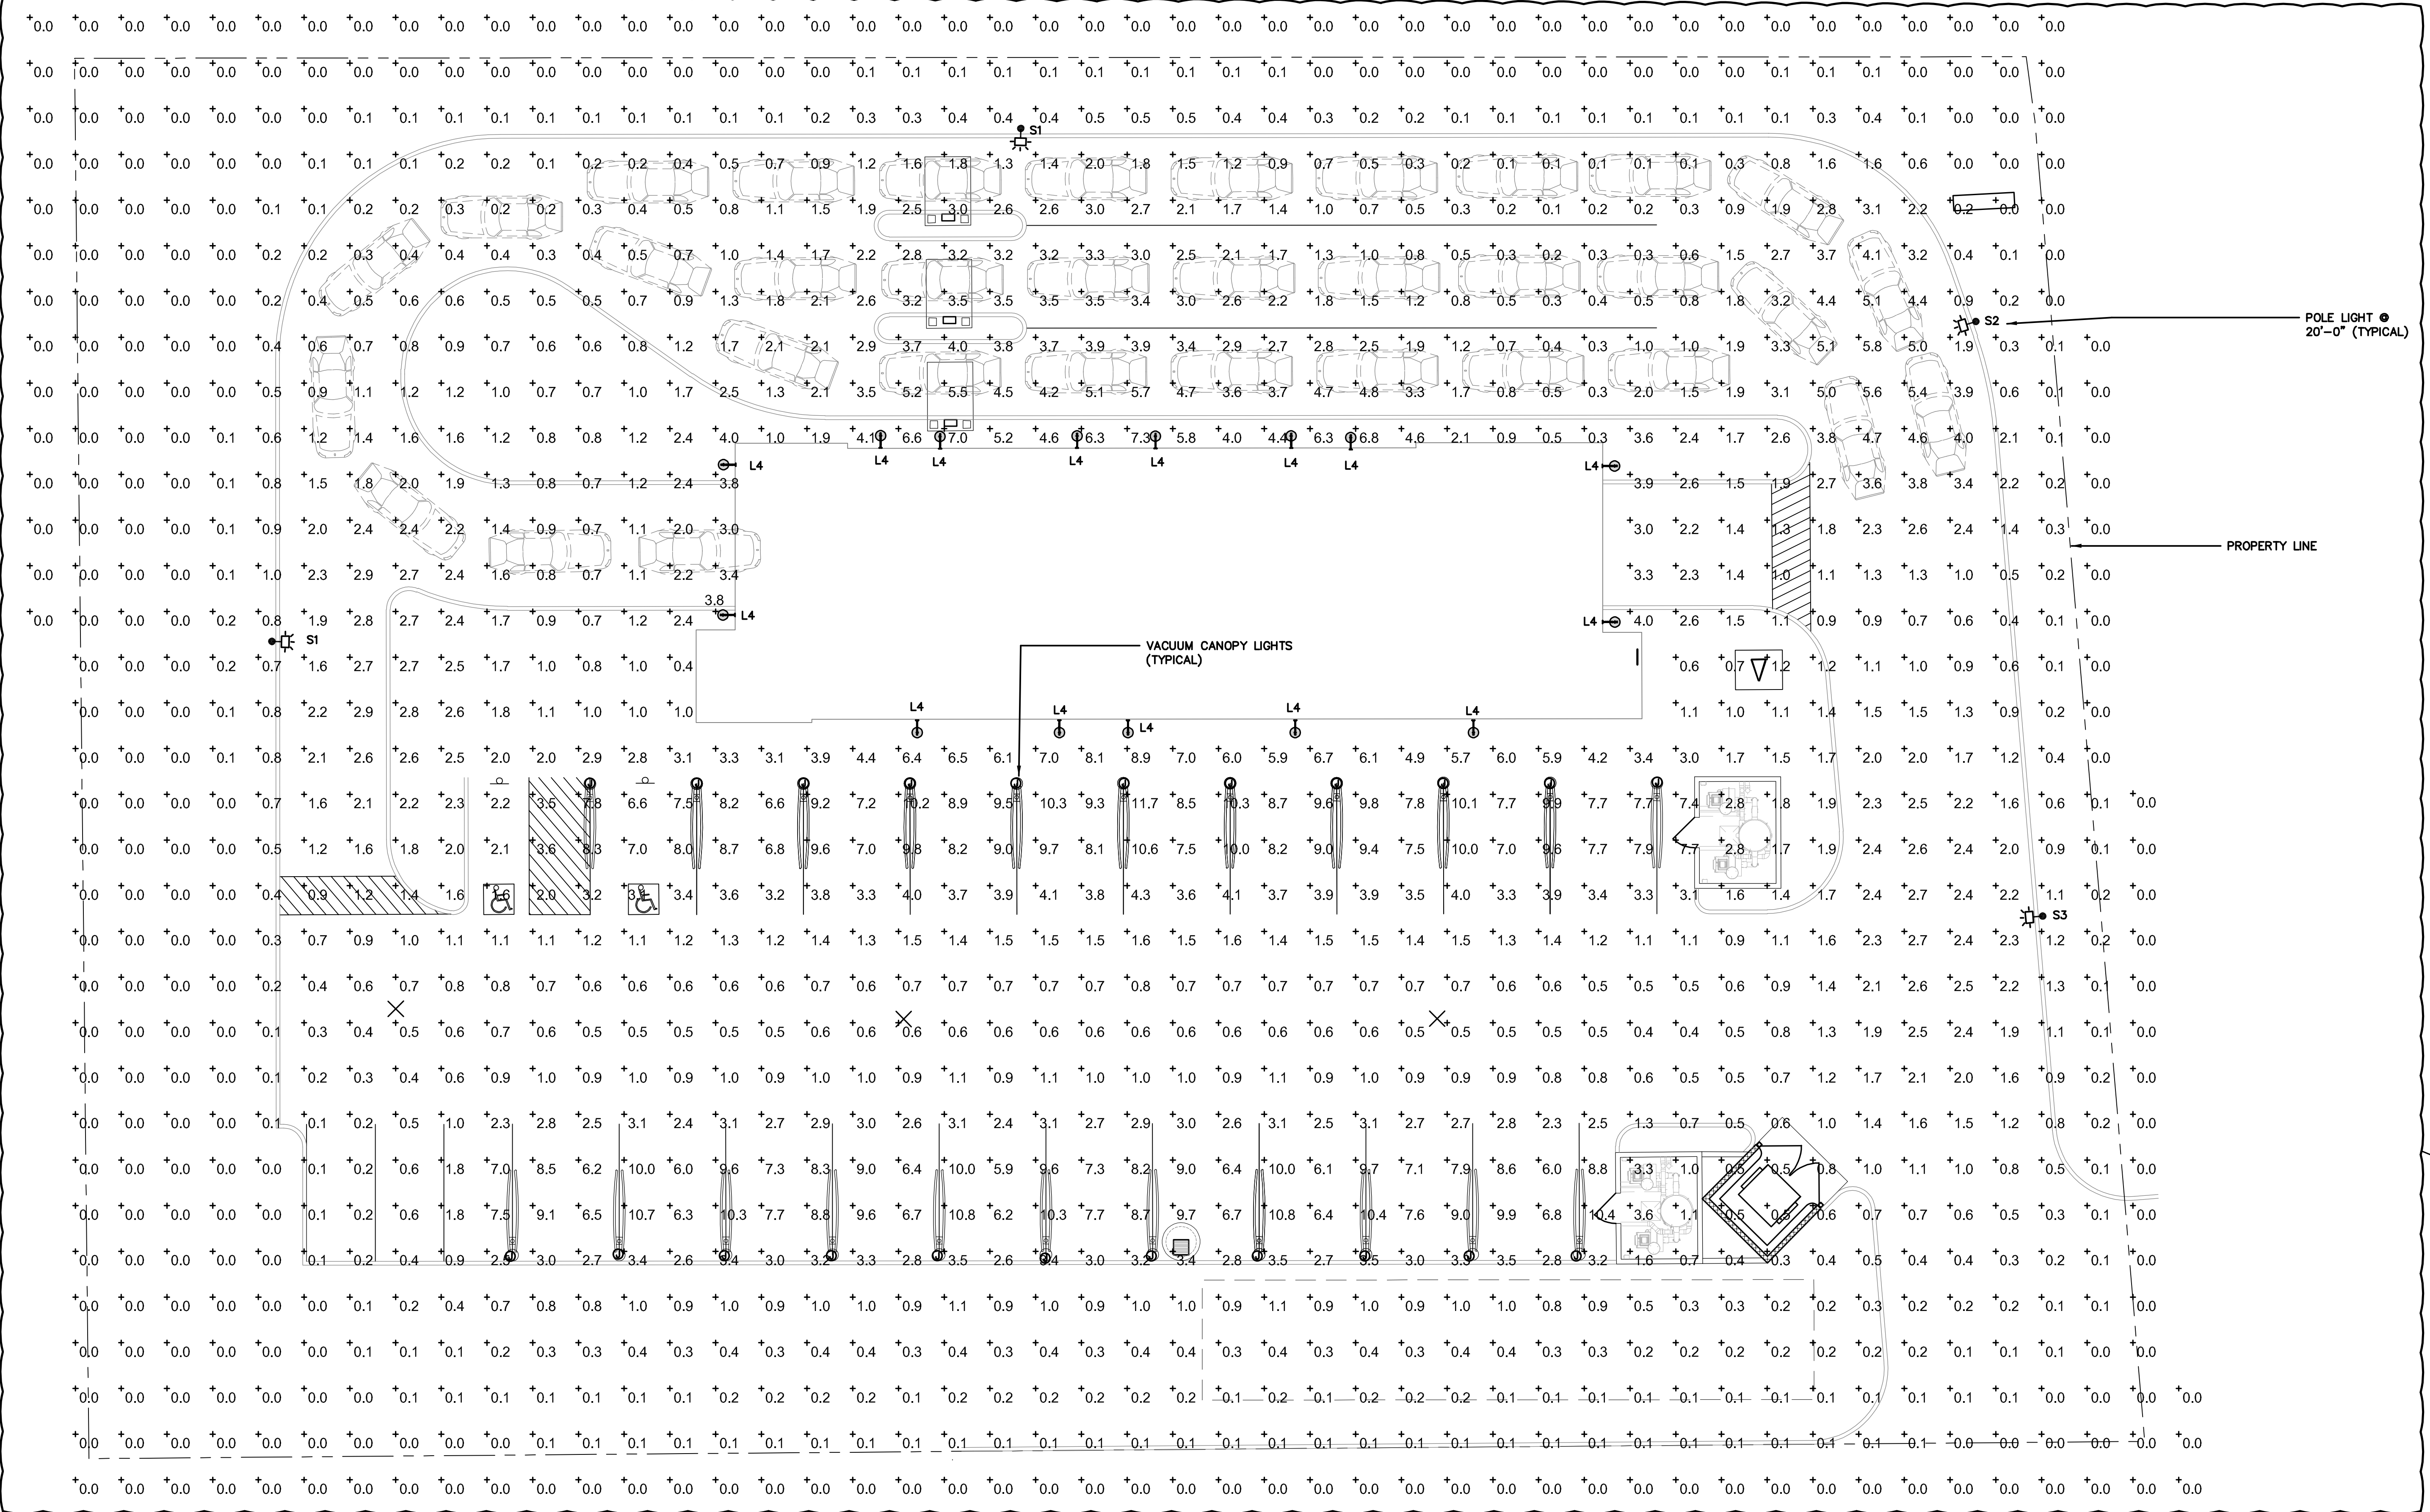

SITE PLAN - ELECTRICAL

SCALE: 3/32"=1'-0"

0' 8' 16' 24' 32' 40' 48'

NORTH

Notes:

1. Calculation @ ground level.

Statistics						
Description	Symbol	Avg	Max	Min	Max/Min	Avg/Min
SITE	+	1.6 fc	11.7 fc	0.0 fc	N/A	N/A

- THIS LIGHTING DESIGN IS BASED ON INFORMATION SUPPLIED BY OTHERS. CHANGES IN ELECTRICAL SUPPLY, AREA GEOMETRY AND OBJECTS WITHIN THE LIGHTED AREA MAY PRODUCE ILLUMINATION VALUES DIFFERENT FROM THE PREDICTED RESULTS SHOWN ON THIS LAYOUT.

- THIS LAYOUT IS BASED ON .IES FILES THAT WERE LAB TESTED OR COMPUTER GENERATED. ACTUAL RESULTS MAY VARY.